

2525 E Burnside St. Portland, OR 97214 seallp.com

NEHALEM BAY **HEALTH CENTER** & PHARMACY

Job Number:

TAX LOT 400, U.S. HIGHWAY 101 WHEELER, OREGON 97147





205 SE Spokane Street, Suite 200, Portland, OR 97202 phone: 503.221.1131 www.hhpr.com fax: 503.221.1171

GENERAL NOTES:

_ SIGHT TRIANGLE

- REFER TO LANDSCAPE PLANS FOR DETAILS OF FLATWORK AND PLANTER AREAS.
- ALL CONCRETE REMOVALS SHALL BE TO THE NEAREST WEAKENED PLANE JOINT OR SCORE MARK.

CONSTRUCTION NOTES:

- 1) CONSTRUCT STANDARD CONCRETE CURB PER DETAIL ON SHEET C5.00. (2) CONSTRUCT FLUSH CONCRETE CURB PER DETAIL ON SHEET C5.00.
- 4)CONSTRUCT ASPHALT PAVEMENT SECTION PER DETAIL ON SHEET C5.00
- CONSTRUCT CONCRETE CURB WALL PER DETAIL ON SHEET C5.00
- (6) Standard Parking Stall. Stripe per detail on sheet c5.00.
- (7) COMPACT PARKING STALL. STRIPE PER DETAIL ON SHEET C5.00.
- (8) EV-READY PARKING STALL. REFER TO ELECTRICAL PLANS FOR INFORMATION.
- 9) INSTALL PRECAST CONCRETE WHEELSTOP PER DETAIL ON SHEET C5.00.
- (10) INSTALL ADA PARKING STALL STRIPING AND SIGNAGE PER DETAIL ON SHEET C5.00.
- (11) INSTALL VAN ACCESSIBLE ADA PARKING STALL STRIPING AND SIGNAGE PER DETAIL ON SHEET C5.00.
- $\widehat{(12)}$ INSTALL LOADING AREA STRIPING PER DETAIL ON SHEET C5.00.
- (13) RETAINING WALL PER LANDSCAPE ARCHITECT'S PLANS.
- (14) STAIRWAY AND HANDRAILING PER LANDSCAPE ARCHITECT'S PLANS.
- (15) LANDSCAPE AREA PER LANDSCAPE ARCHITECT'S PLANS. 16) PEDESTRIAN HARDSCAPE PER LANDSCAPE ARCHITECT'S PLANS.
- (17) BOLLARD PER LANDSCAPE ARCHITECT'S PLANS.
- (18) CONSTRUCT LANDSCAPE ISLAND CUT THROUGH PER DETAIL ON SHEET C5.00.
- (19) TRASH ENCLOSURE PER ARCHITECTURAL PLANS.
- (20) 2" GRIND AND OVERLAY EXISTING ASPHALT PAVEMENT. MATCH EXISTING GRADE. (21) RECONSTRUCT EXISTING CONCRETE CURB PER ODOT STD. DWG. RD700. MATCH EXISTING
- RECONSTRUCT EXISTING CONCRETE CURB TIGHT SIDEWALK PER ODOT STD. DWG. RD720. MATCH EXISTING GRADES.
- (23) MONUMENT SIGN PER ARCHITECTURAL PLANS.
- (24) SITE LIGHTING. REFER TO LIGHTING PLANS.


DESIGN DEVELOPMENT ISSUE

Drawing:

CIVIL SITE PLAN

11.29.2023

DATE

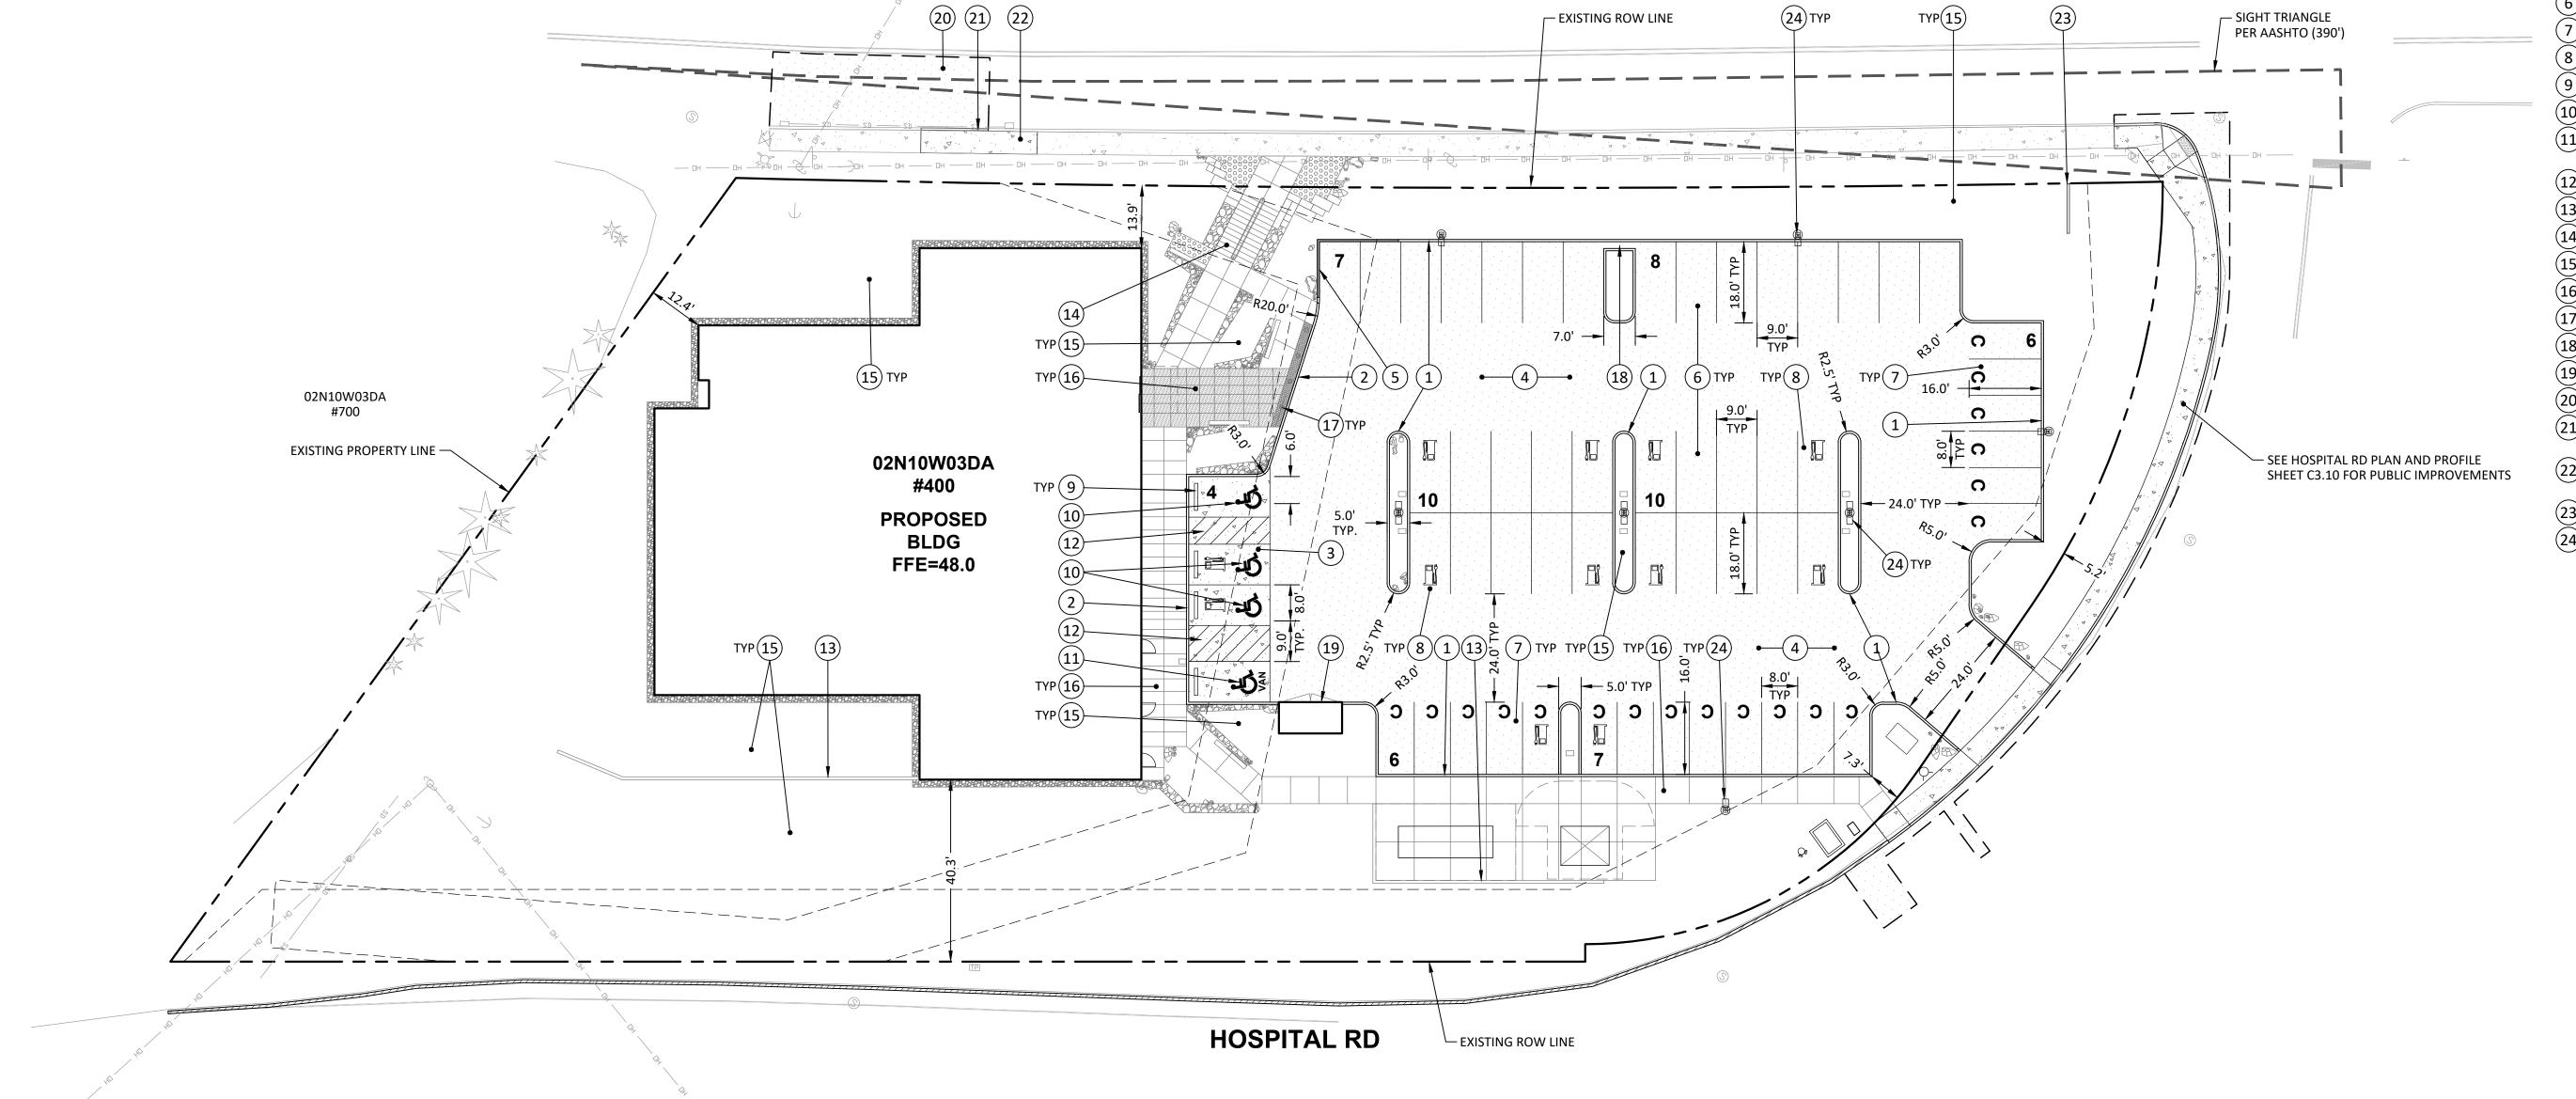

OREGON COAST HWY (US 101)

EXISTING ROW LINE



2525 E Burnside St. 503.226.3617 Portland, OR 97214 seallp.com

PRIVATE STORM NOTES:

- 1. PVC PIPE TO BE SDR35, ASTM D-3034 UNLESS OTHERWISE NOTED. PIPE BEDDING AND BACKFILL PER DETAIL ON SHEET C5.01.
- 2. ALL PIPE LENGTHS ARE MEASURED FROM INSIDE WALL OF STRUCTURE AND CENTER OF FITTING TO CENTER OF FITTING.
- 3. ALL PIPE LENGTHS SHOWN HEREON ARE APPROXIMATE ONLY. CONTRACTOR IS RESPONSIBLE FOR ALL QUANTITY TAKEOFFS TO CONSTRUCT THE DESIGN SHOWN ON THESE PLANS.
- 4. NO BUILDING SEWER OR OTHER DRAINAGE PIPING OR PART THEREOF, CONSTRUCTED OF MATERIAL OTHER THAN THOSE APPROVED FOR USE UNDER OR WITHIN A BUILDING, SHALL BE INSTALLED UNDER OR WITHIN 5 FEET OF A BUILDING OR STRUCTURE, OR LESS THAN 1 FOOT BELOW THE SURFACE OF THE GROUND PER SECTION 312.3 OF THE 2019 OREGON PLUMBING SPECIALTY CODE.

PRIVATE SANITARY NOTES:

- 1. PVC PIPE TO BE SDR35, ASTM D-3034 UNLESS OTHERWISE NOTED. PIPE BEDDING AND BACKFILL PER DETAIL ON SHEET C5.01.
- 2. PIPE LENGTHS ARE MEASURED FROM EDGE OF MANHOLE TO EDGE OF MANHOLE OR TO THE CENTER OF EACH CLEANOUT. 3. ALL PIPE LENGTHS SHOWN HEREON ARE APPROXIMATE ONLY. CONTRACTOR IS RESPONSIBLE
- FOR ALL QUANTITY TAKEOFFS TO CONSTRUCT THE DESIGN SHOWN ON THESE PLANS. 4. NO BUILDING SEWER OR OTHER DRAINAGE PIPING OR PART THEREOF, CONSTRUCTED OF MATERIAL OTHER THAN THOSE APPROVED FOR USE UNDER OR WITHIN A BUILDING. SHALL BE INSTALLED UNDER OR WITHIN 5 FEET OF A BUILDING OR STRUCTURE, OR LESS THAN 1 FOOT BELOW THE SURFACE OF THE GROUND PER SECTION 312.3 OF THE 2019 OREGON PLUMBING

PRIVATE WATER NOTES:

SPECIALTY CODE.

- 1. PRIVATE WATER PIPE TO BE SCH 40 PVC PIPE UNLESS OTHERWISE NOTED. 2. PRIVATE FIRE PIPE TO BE C900 PVC PIPE WITH A DIMENSION RATIO OF NO GREATER THAN 18
- UNLESS OTHERWISE NOTED. 3. PROVIDE 3' OF COVER FROM FINISHED GRADE TO TOP OF PIPE. PIPE BEDDING AND TRENCH
- BACKFILL PER DETAIL ON SHEET C5.01.
- 4. ALL PIPE LENGTHS SHOWN HEREON ARE APPROXIMATE ONLY. CONTRACTOR IS RESPONSIBLE FOR ALL QUANTITY TAKEOFFS TO CONSTRUCT THE DESIGN SHOWN ON THESE PLANS.

CONSTRUCTION NOTES:

- 1) INSTALL 24" CATCH BASIN PER DETAIL ON SHEET C5.01.
- (2) CONNECT TO NEW PUBLIC STORM SYSTEM. SEE PUBLIC STORM PLAN AND PROFILE SHEET FOR ADDITIONAL INFORMATION.
- (3) CONSTRUCT PERIMETER FOUNDATION DRAIN PER DETAILS ON SHEET C5.01.

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OREGON COAST HWY (US 101)

EX. 8" SAN

─ EXISTING ROW LINE

67.7 LF 8" PVC STM S=0.0200

2 SDMH-02

T 15.0' PUBLIC STORM ESMT

125.0 LF 2" WTR

(1) SDCB-01

5.0 LF 4" FIRE -

4" IE=31.3±(12) 3 (11) SSCO-01 (2)6" IE=38.17

4" IE=40.0 (10) (3) (4)

59.7 LF 6" PVC STM S=0.0200 ~

5.0 LF 6" PVC STM S=0.0200-

EXISTING FIRE HYDRANT TO REMAIN

02N10W03DA

#400

PROPOSED

BLDG

FFE=48.0

EX. 8" WTR

15.6 LF 4" PVC SAN S=0.2932—

14.0 LF 4" PVC SAN S=0.2932—

22.4 LF 6" PVC STM S=0.0200-

(3)(6) SDCO-01(5)

PUBLIC STORM MAIN PER SHEET C4.10 -

EXISTING FIRE HYDRANT TO REMAIN —

02N10W03DA #700

EXISTING PROPERTY LINE -

- 4) CONNECT FOUNDATION DRAIN TO STORM SYSTEM. INSTALL BACKWATER VALVE
- (CLEANCHECK OR EQUAL) ON SOLID STORM PIPE WITH CAST IRON CLEANOUT FRAME AND
- (5) INSTALL STORM CLEANOUT PER DETAIL ON SHEET C5.01.
- (6) CONSTRUCT FRENCH DRAIN WITH OVERFLOW DRAINS PER DETAIL ON SHEET C5.01.
- 7 CONNECT FRENCH DRAIN TO STORM SYSTEM.
- (10) 4" SANITARY BUILDING POINT OF CONNECTION. REFER TO PLUMBING PLANS FOR CONTINUATION.
- (11) INSTALL SANITARY CLEANOUT PER DETAIL ON SHEET C5.01.
- (12) CONNECT TO EXISTING PUBLIC 8" SANITARY SEWER MAIN.
- (20) 2" DOMESTIC WATER SERVICE BUILDING POINT OF CONNECTION. REFER TO PLUMBING PLANS FOR CONTINUATION. DOMESTIC REDUCED PRESSURE BACKFLOW ASSEMBLY LOCATED INSIDE BUILDING.
- (21) 4" FIRE WATER SERVICE BUILDING POINT OF CONNECTION. REFER TO FIRE DESIGNER'S PLANS FOR INFORMATION.
- CONSTRUCT 2" SCH. 40 PVC DOMESTIC WATER SERVICE IN TRENCH PER DETAIL ON SHEET C5.01.
- (23) CONSTRUCT 4" C900 PVC FIRE WATER SERVICE IN TRENCH PER DETAIL ON SHEET C5.01.
- RESTRAIN ALL JOINTS.
- (24) CONSTRUCT 4" FDC PER DETAIL ON SHEET C5.01.

INFORMATION.

- (25) Install 4" DCDA in vault per detail on sheet C5.01. Refer to hospital RD Plan &PROFILE SHEET FOR ADDITIONAL INFORMATION.
- (26) INSTALL 2" DOMESTIC WATER METER. REFER TO HOSPITAL RD PLAN & PROFILE SHEET FOR
- (27) CONSTRUCT BEND IN WATERLINE. BEND ANGLE PER PLAN.
- (28) 2" IRRIGATION POINT OF CONNECTION. REFER TO LANDSCAPE ARCHITECT'S PLANS FOR INFORMATION.
- (30) NEW UNDERGROUND POWER BY OTHERS. REFER TO TPUD PLANS.
- (31) NEW SECTIONALIZER VAULT BY OTHERS. REFER TO TPUD PLANS.
- (32) NEW ELECTRICAL TRANSFORMER BY OTHERS. REFER TO TPUD PLANS.
- (33) NEW GENERATOR BY OTHERS. REFER TO MEP PLANS.
- (34) NEW SITE LIGHTING BY OTHERS. REFER TO LIGHTING PLANS.

STORM DRAINAGE DATA						
NUMBER	RIM		INVERT ELEV.			
SDCB-01	24" AREA DRAIN	45.24	8" PVC IE OUT (SW)= 42.07			
SDCO-01	STORM CLEANOUT	53.89	6" PVC IE IN (NW) = 44.70 6" PVC IE OUT (NE)= 44.70			
SDMH-02	48" STANDARD MANHOLE	46.57	15" PVC IE IN (S) = 38.86 8" PVC IE IN (NE) = 40.72 16" C900 IE OUT (W)= 38.76			
SDMH-03	48" STANDARD MANHOLE	50.22	15" PVC IE IN (SW) = 41.52 6" PVC IE IN (W) = 43.27 15" PVC IE OUT (N)= 41.42			

	SANITARY STRUCTURE DATA						
NUMBE	R	DESCRIPTION	RIM ELEV.	INVERT ELEV.			
SSCO-0	1 SA	ANITARY CLEANOUT	43.62	4" PVC IE IN (SE) = 35.89 4" PVC IE OUT (NW) = 35.89			




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WHEELER, OREGON 97147





ENGINEERS + PLANNERS

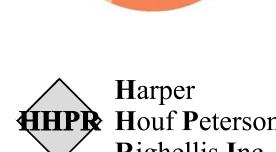205 SE Spokane Street, Suite 200, Portland, OR 97202 phone: 503.221.1131 www.hhpr.com fax: 503.221.1171

60% CONSTRUCTION 03.15.2024 DATE

Drawing: **UTILITY PLAN**

ILLUMINATED BOLLARD
TYP. OF 4, REF. ELECTRICAL
AND LIGHTING CIP CONCRETE PAVING
PEDESTRIAN - SAND FINISH TRUNCATED DOMES
CAST METAL BOULDER, TYP. CIP CONCRETE PAVING PEDESTRIAN <u>LIGHT POLE FOOTING, TYP.</u> REF. ELECTRICAL AND LIGHTING EV CHARGING STATION REF. ELECTRICAL REF. ARCH 1/4" MINUS AGGREGATE PAVING MAINTENANCE PATH

PEDESTRIAN PLAZA DETAIL PLAN ENLARGEMENT

SCALE: 1"= 10'-0"

BOULDER SLAB SEATING AT STEPS

1/4" MINUS AGGREGATE

DOUBLE HANDRAIL AT STEPS, ILLUMINATED

CIP CONCRETE STEPS
TYP. 0F 12

STONE SCREE, TYP.

TIMBER SEATING, TYP. 0F 4

BOULDER TYP.

PAVING

METAL EDGING

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NEHALEM BAY
HEALTH
DISTRICT

2222 NE Oregon St Suite 213 Portland OR 97232 971 268 8570

range-studio.com

seallp.com


— – — PROPERTY LINE


TREE TO REMAIN


PLANTING LEGEND



THESE DRAWINGS ARE THE ORIGINAL UNPUBLISHED WORK OF THE ARCHITECT AND MAY NOT BE DUPLICATED OR USED WITHOUT THE WRITTEN CONSENT OF THE ARCHITECT.

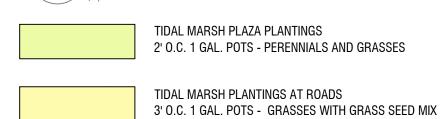

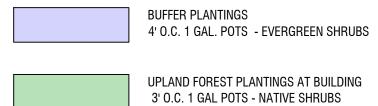

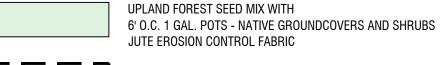

VEGETATIVE SCREEN
5 GAL. EVERGREEN NATIVE SHRUBS
48" O.C.

60% CONSTRUCTION DOCUMENTS ISSUE Drawing:

LANDSCAPE **MATERIALS AND PLANTING PLAN**

03.14.2024

DATE

Sheet No:

TAX LOT 400, U.S. HIGHWAY 101 WHEELER, OREGON 97147







FOOTHILL SEDGE

MANZANITA 'SUNSET'

CREEPING RASPBERRY






ROSEMARY

COYOTE BUSH




YARROW



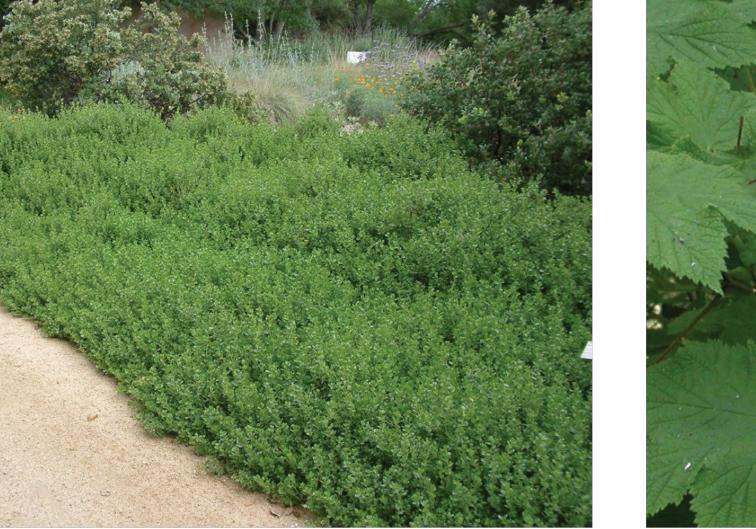

THIMBLEBERRY

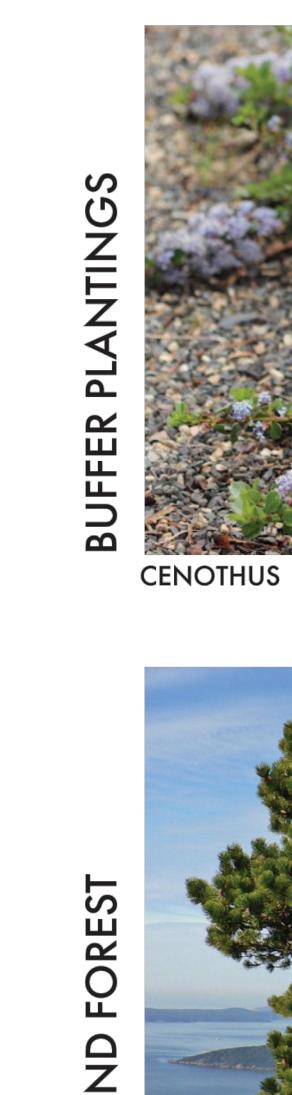


JUNEGRASS

SHORE PINE

03.14.2024

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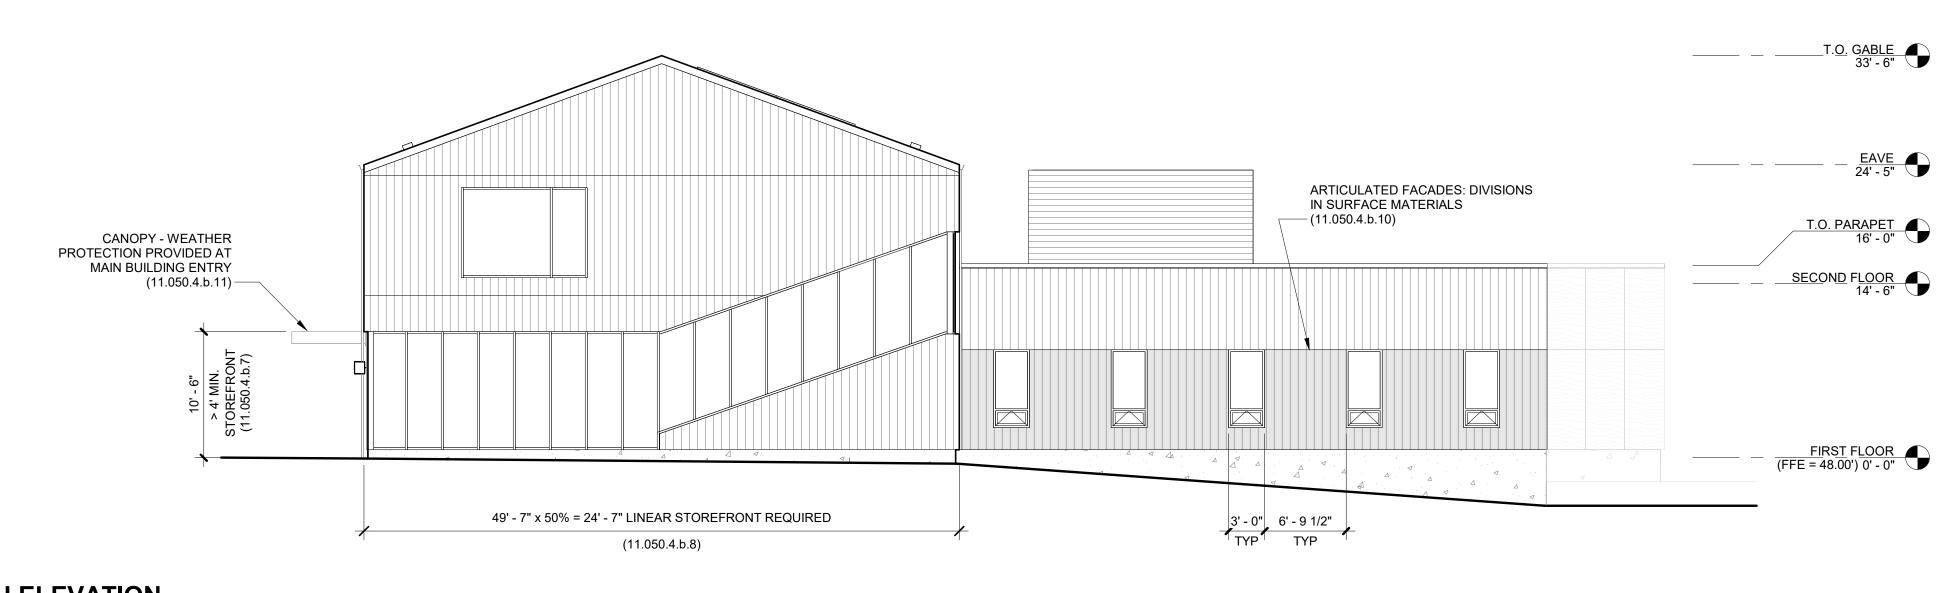
60% CONSTRUCTION 03.15.2024 DOCUMENTS DATE ISSUE

Drawing:

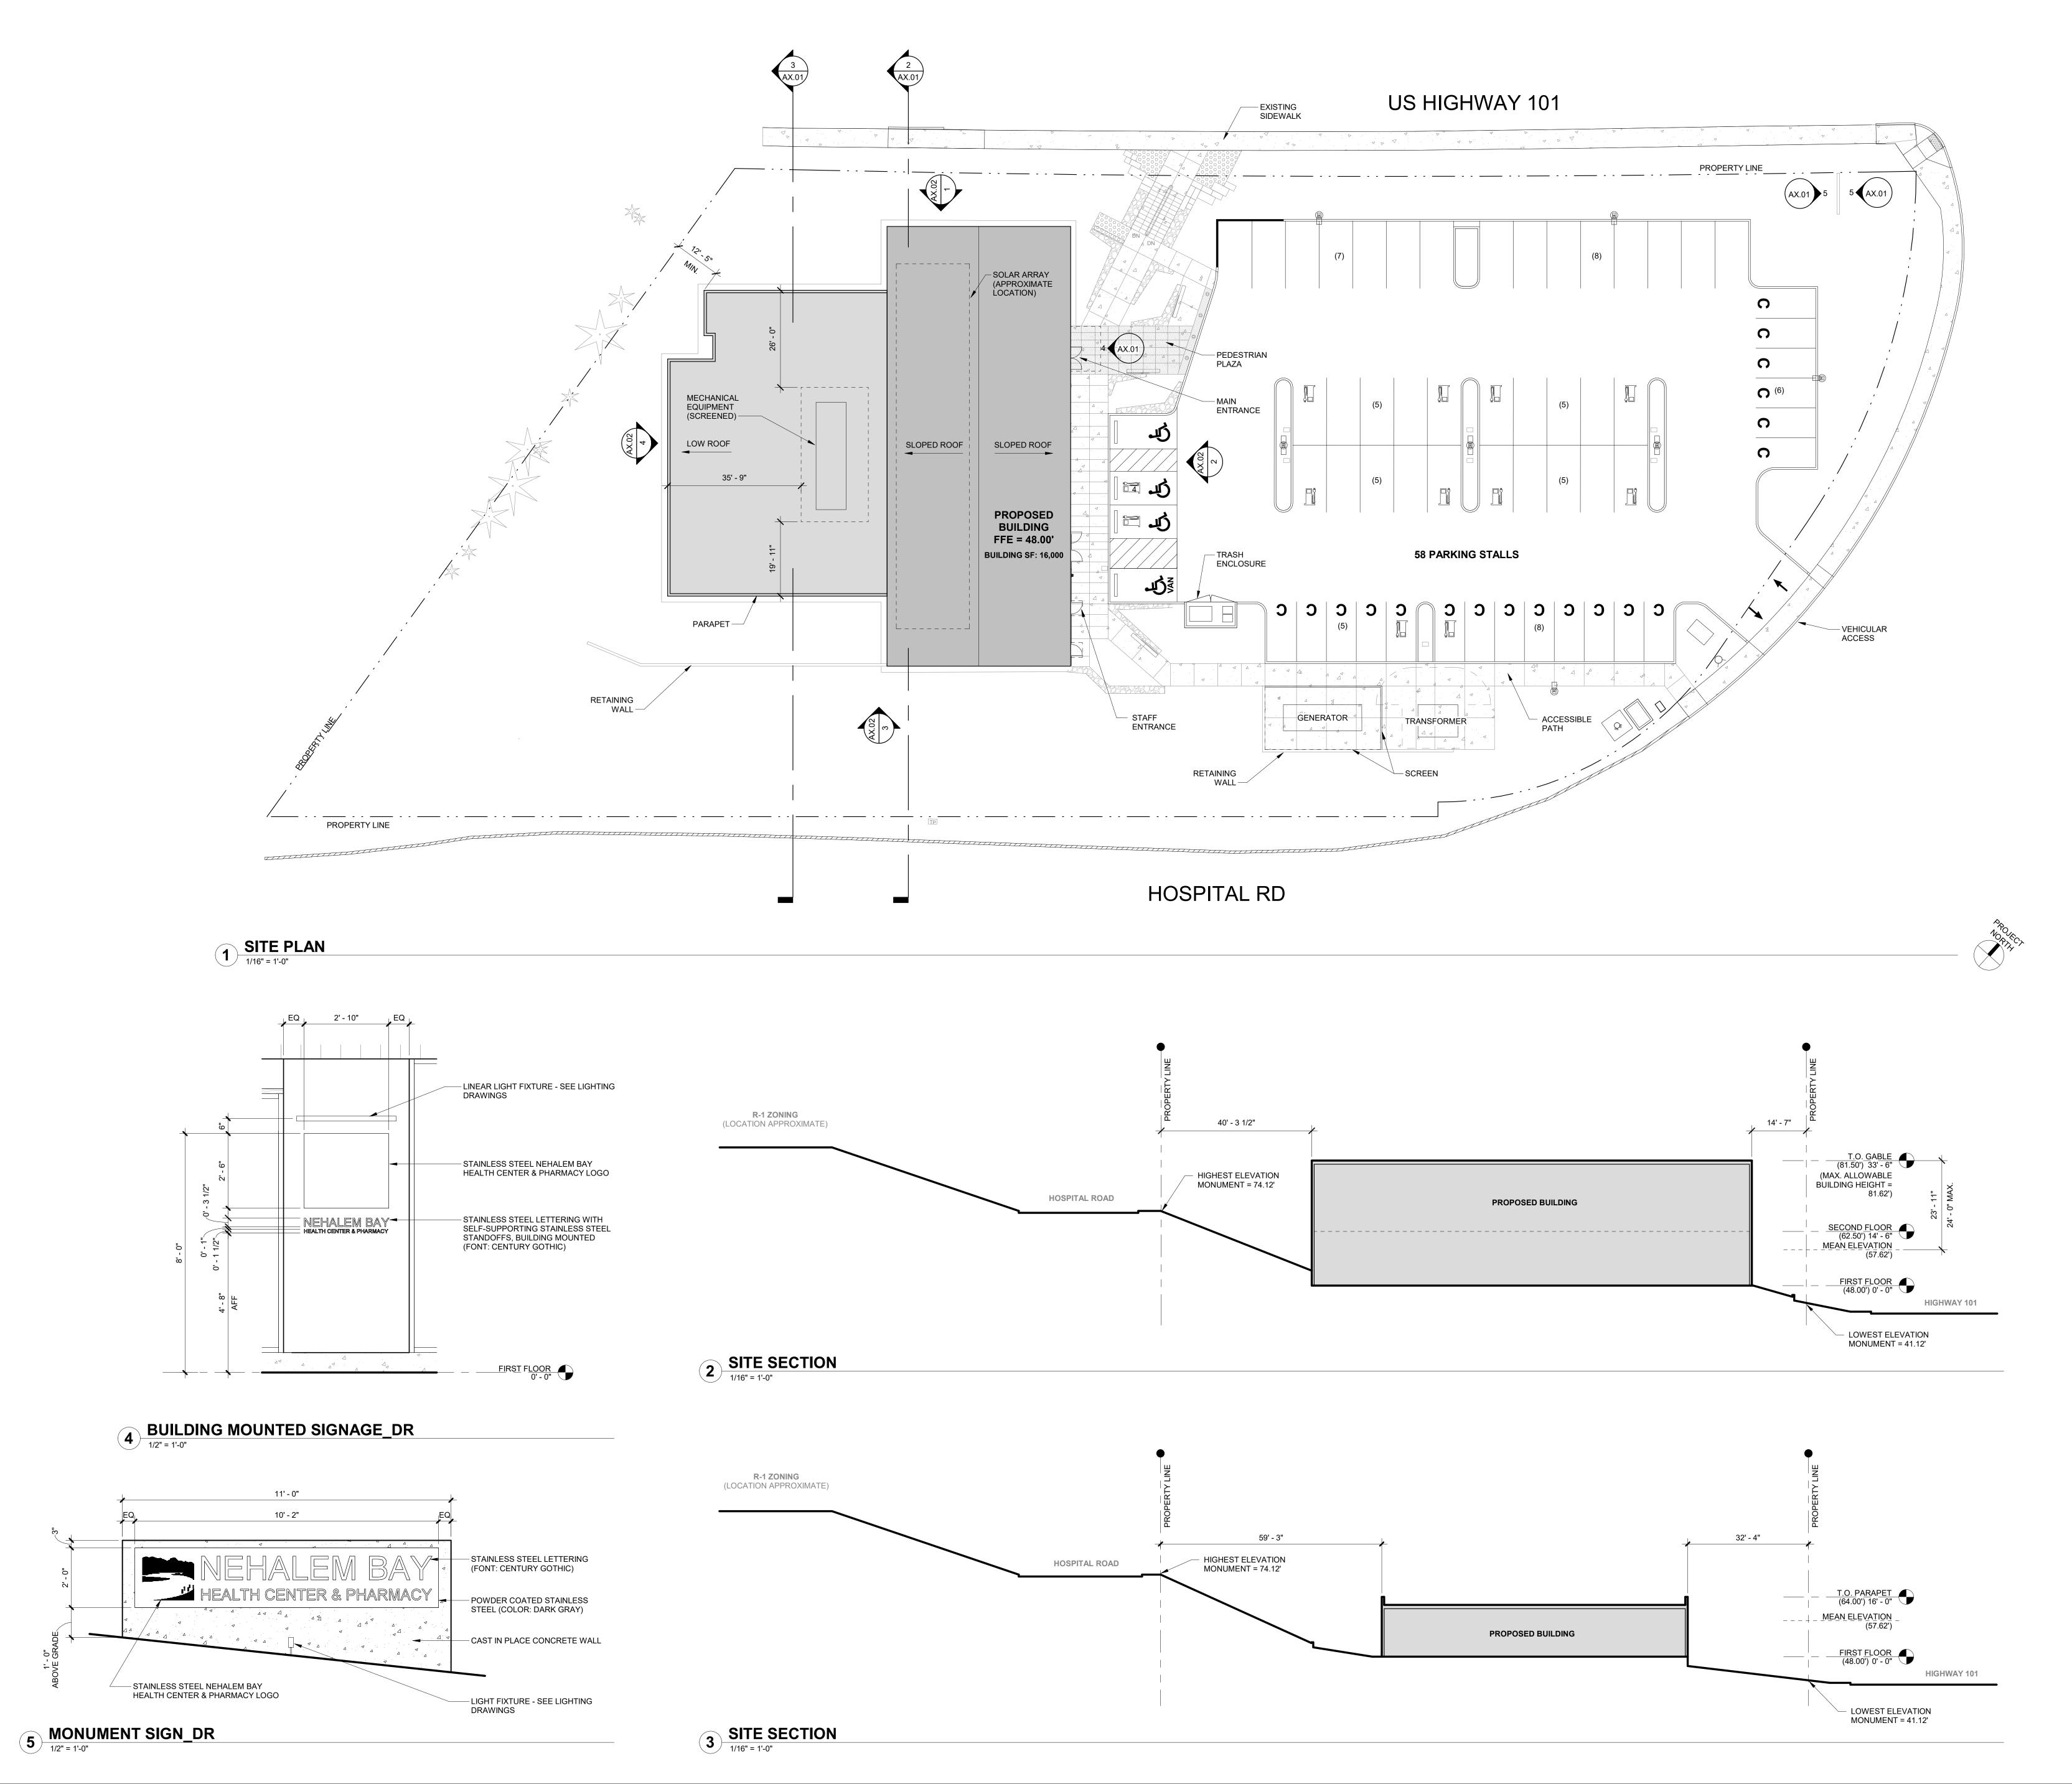
ARCHITECTURAL SITE PLAN, SECTIONS, & DETAILS


Sheet No:

AX.01




NORTH ELEVATION 1/8" = 1'-0"

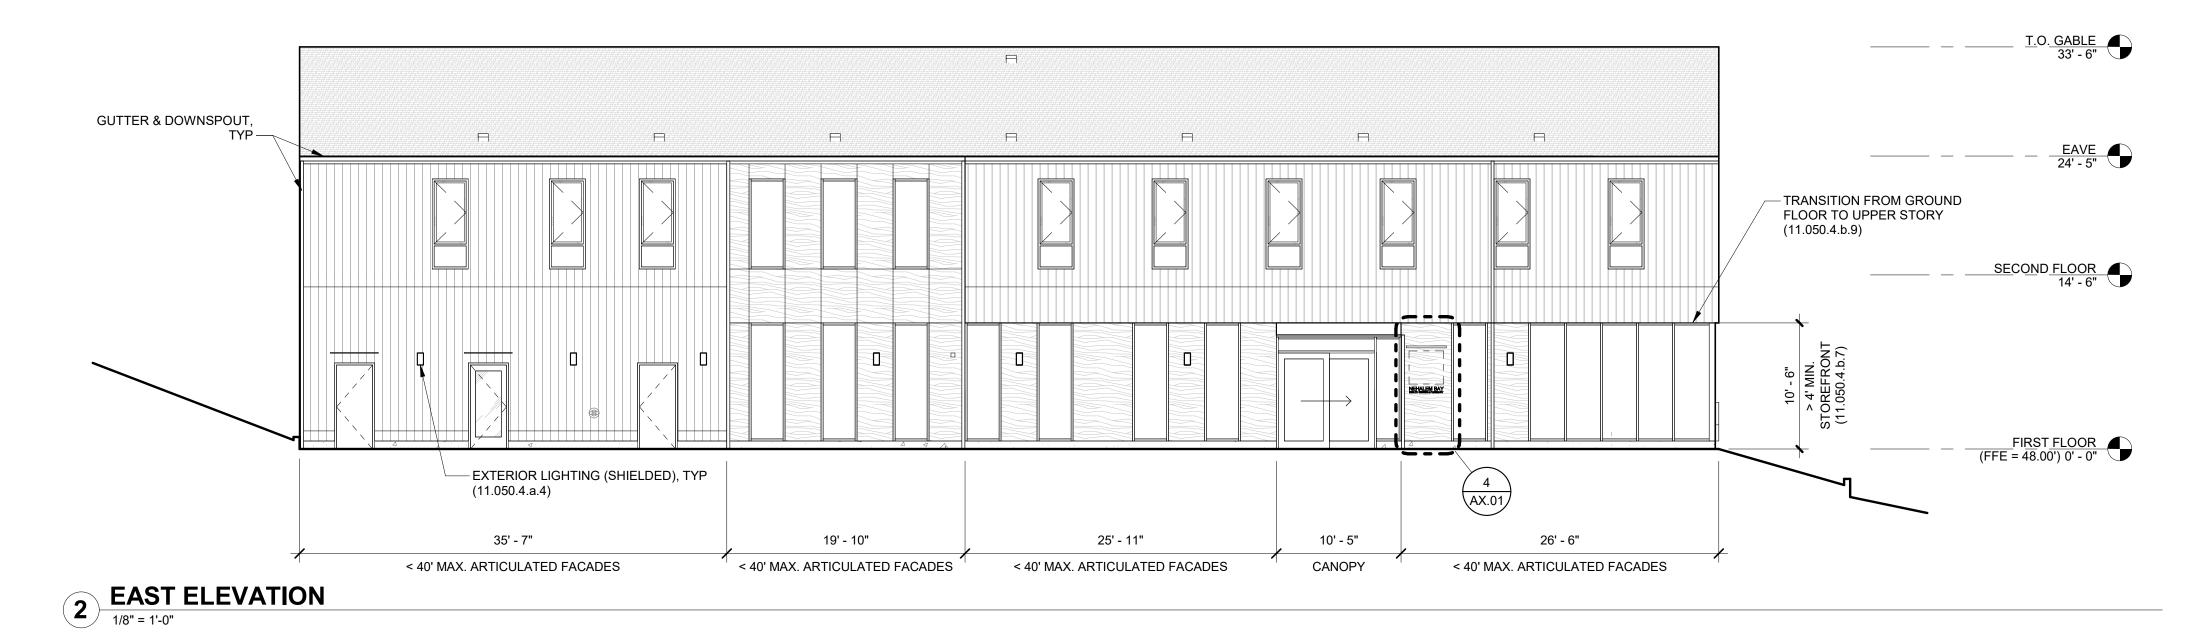


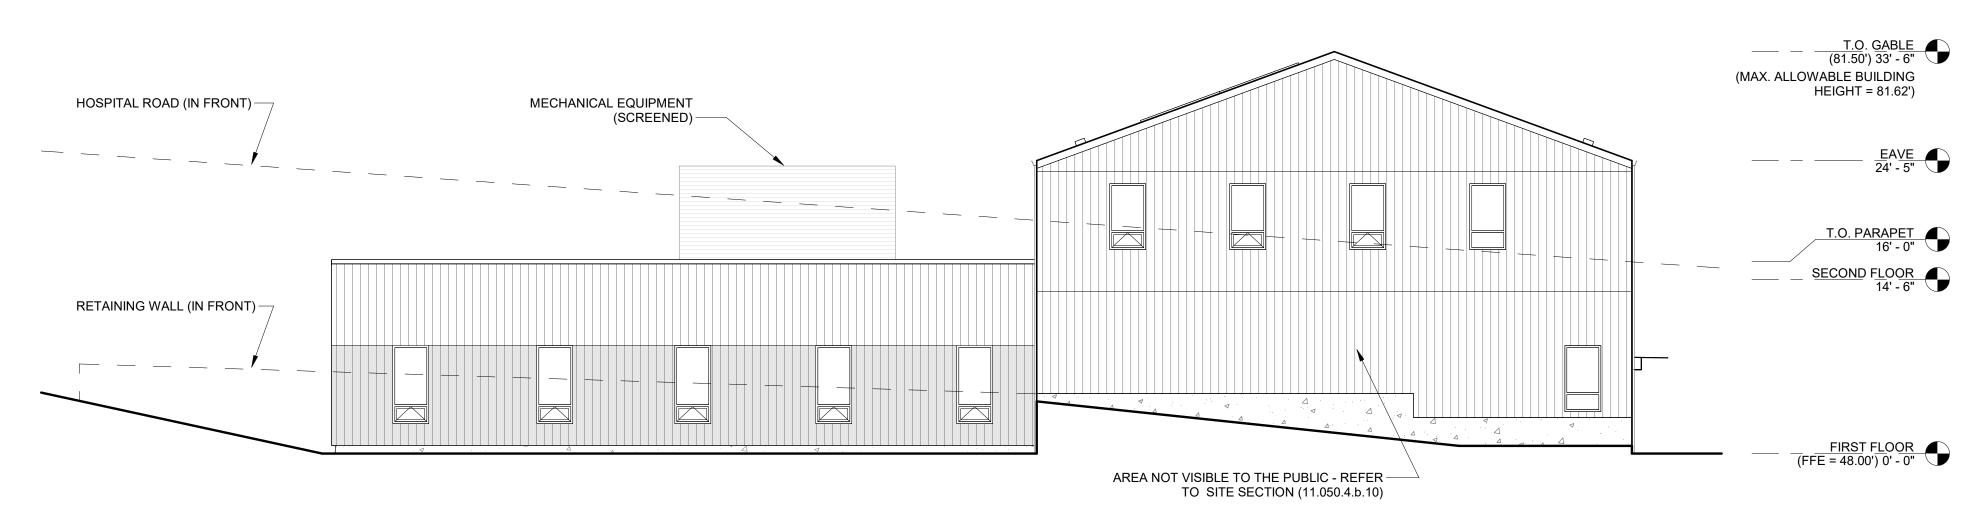

3 SOUTH ELEVATION 1/8" = 1'-0"

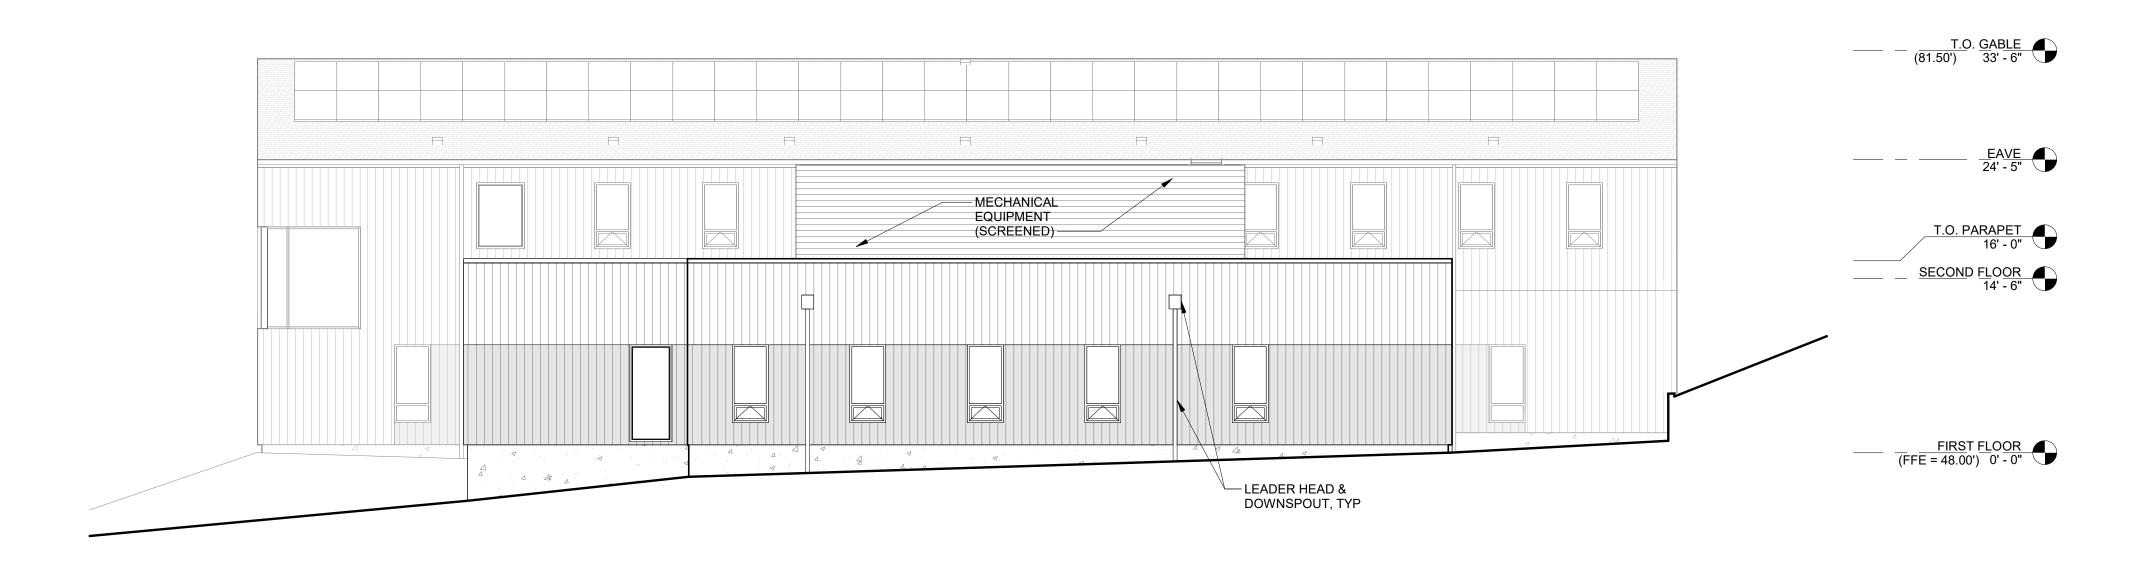



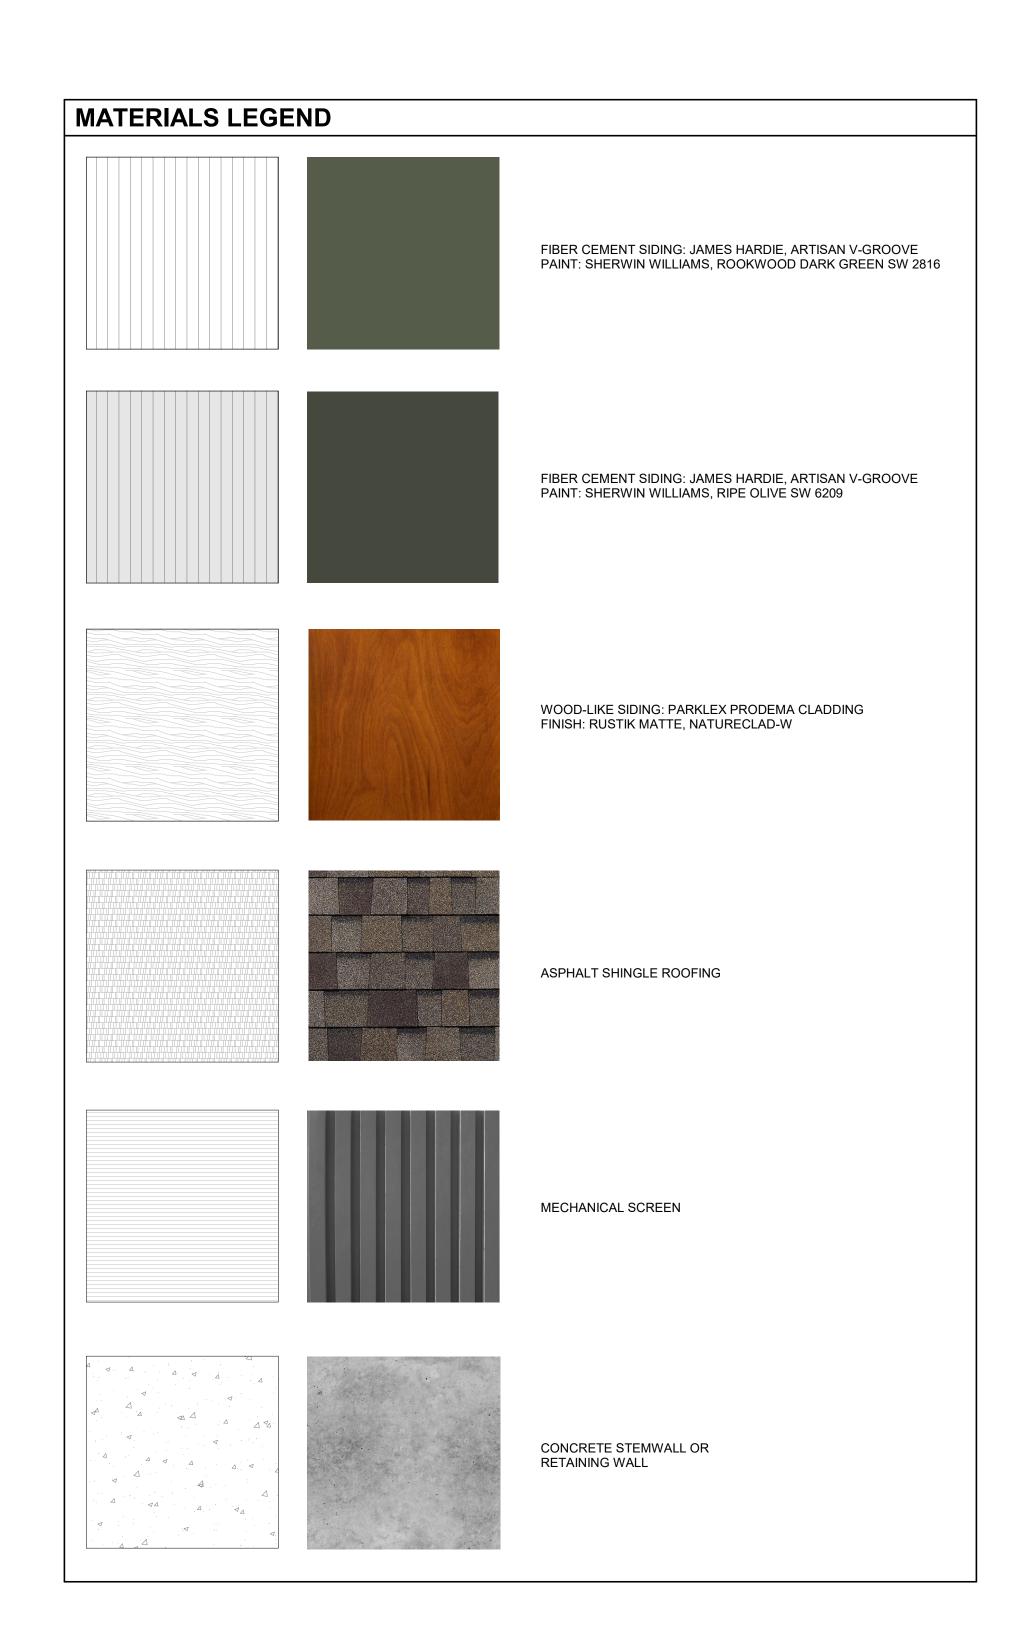

60% CONSTRUCTION 03.15.2024
DOCUMENTS
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Drawing:

EXTERIOR ELEVATIONS & MATERIALS

Sheet No:

AX.02